2022 GREEN INFRASTRUCTURE PROJECT BID #22-15

INDEX	SHEET NO.
Cover Sheet	1
Locus	2
Trench Locations #1-6	3
Trench Locations #7-12	4
Trench Locations #13-18	5
Trench Locations #19-24	6
Construction Details	7




Massachusetts Office of Coastal Zone Management 251 Causeway Street, Ste 800 Boston, MA 02114




Mystic River Watershed Association 20 Academy St., Ste. 306 Arlington, MA 02476



Town of Arlington
Department of Public Works
51 Grove Street
Arlington, MA 02476

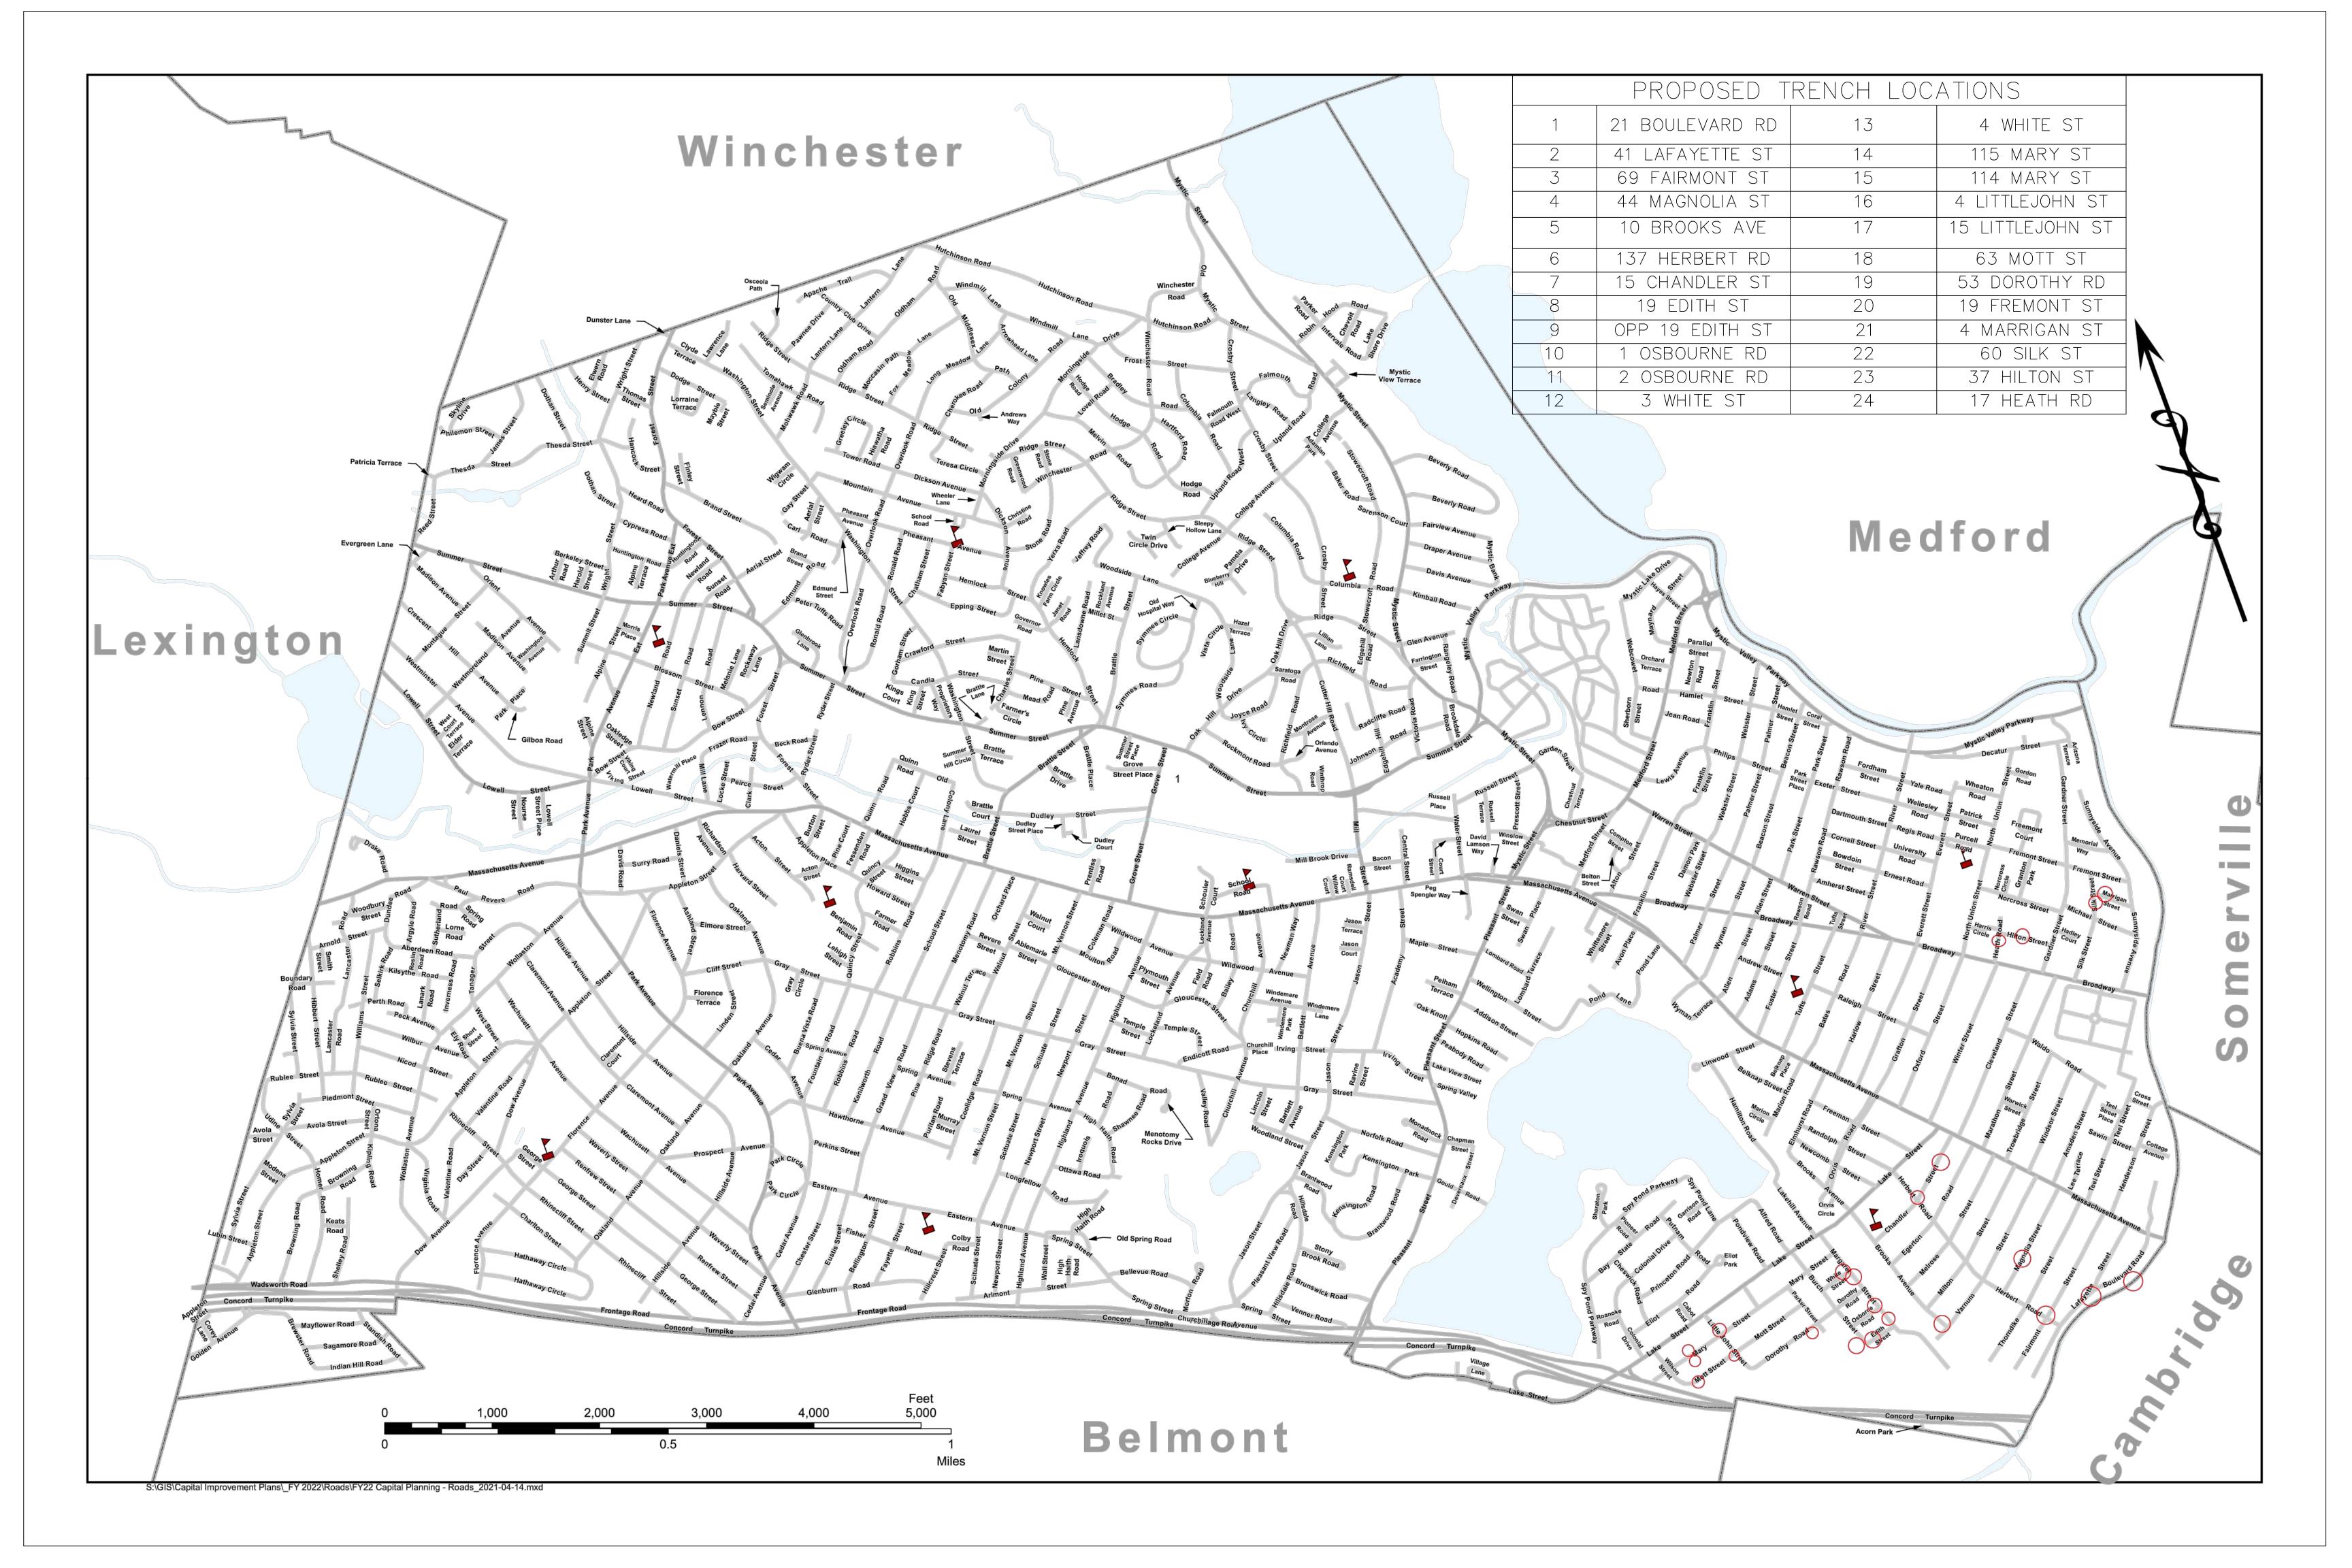


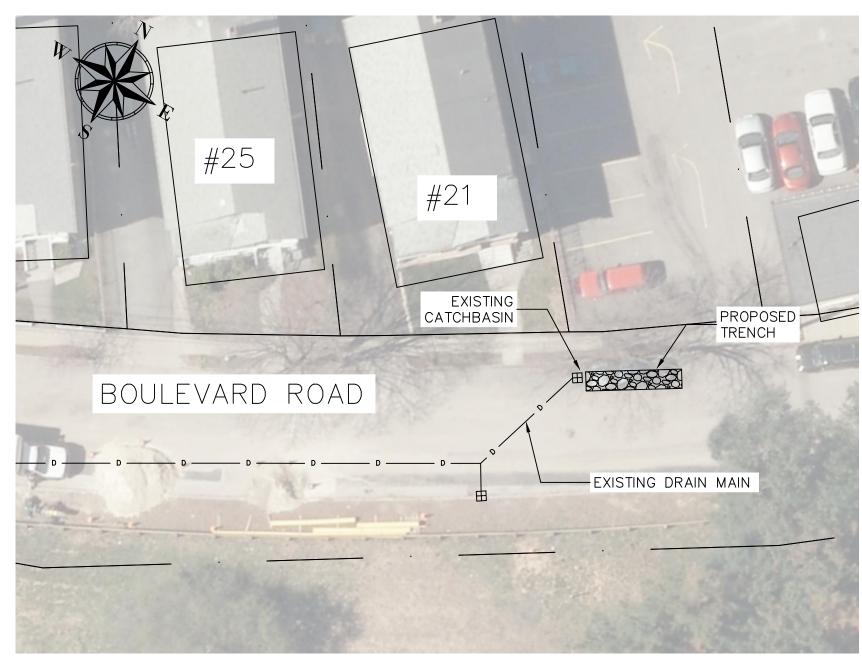

LOCATION#1 - 21 BOULEVARD ROAD


SCALE: N.T.S.

DESIGN & AS-BUILT TABLE		
NEAREST ADDRESS 21 BOULEVARD ROAD		
TRENCH DESIGN	DESIGN	AS-BUILT
LENGTH (FT)	35	
WIDTH (FT)	4	
DEPTH (FT)	6.75	
DEPTH EXISTING INV. OUT (FT)	2.50	
DEPTH TRENCH PIPE INV. (FT)	2.75	
IMPERVIOUS AREA (ACRES)	0.23	

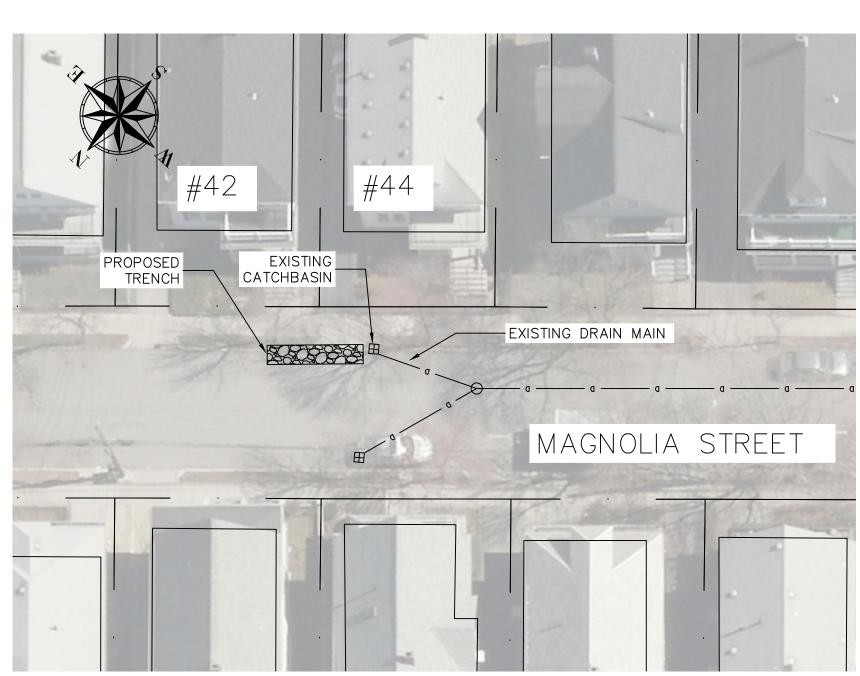

LOCATION #4 - 44 MAGNOLIA STREET


DESIGN & AS-BUILT TABLE		
NEAREST ADDRESS 44 MAGNOLIA STREET		LIA STREET
TRENCH DESIGN	DESIGN	AS-BUILT
LENGTH (FT)	30	
WIDTH (FT)	4	
DEPTH (FT)	6.50	
DEPTH EXISTING INV. OUT (FT)	3.00	
DEPTH TRENCH PIPE INV. (FT)	3.25	
IMPERVIOUS AREA (ACRES)	0.28	

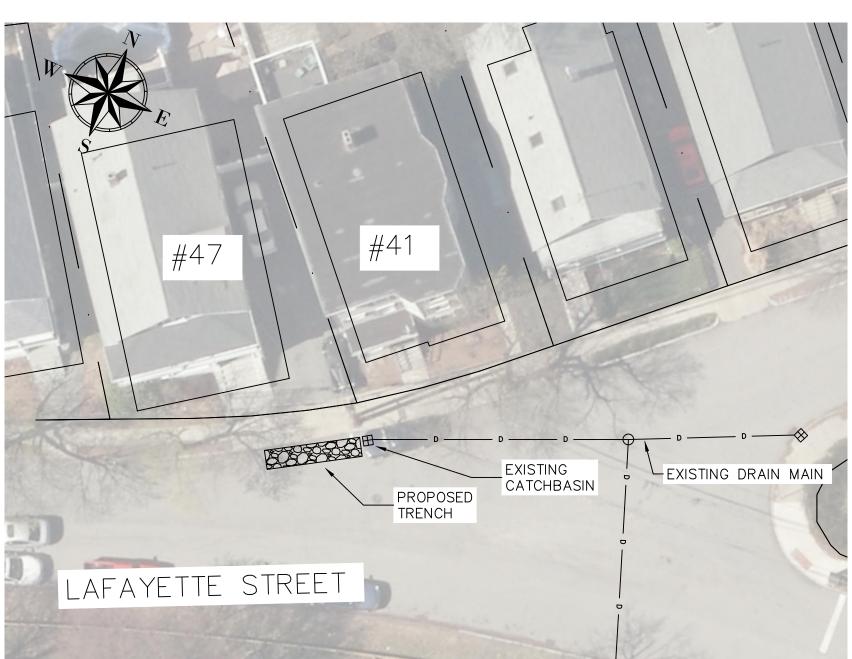

LOCATION #2 - 41 LAFAYETTE STREET


SCALE: N.T.S.

DESIGN & AS-BUILT TABLE		
NEAREST ADDRESS	41 LAFAYETTE STREET	
TRENCH DESIGN	DESIGN	AS-BUILT
LENGTH (FT)	30	
WIDTH (FT)	4	
DEPTH (FT)	6.75	
DEPTH EXISTING INV. OUT (FT)	2.50	
DEPTH TRENCH PIPE INV. (FT)	2.75	
IMPERVIOUS AREA (ACRES)	0.15	

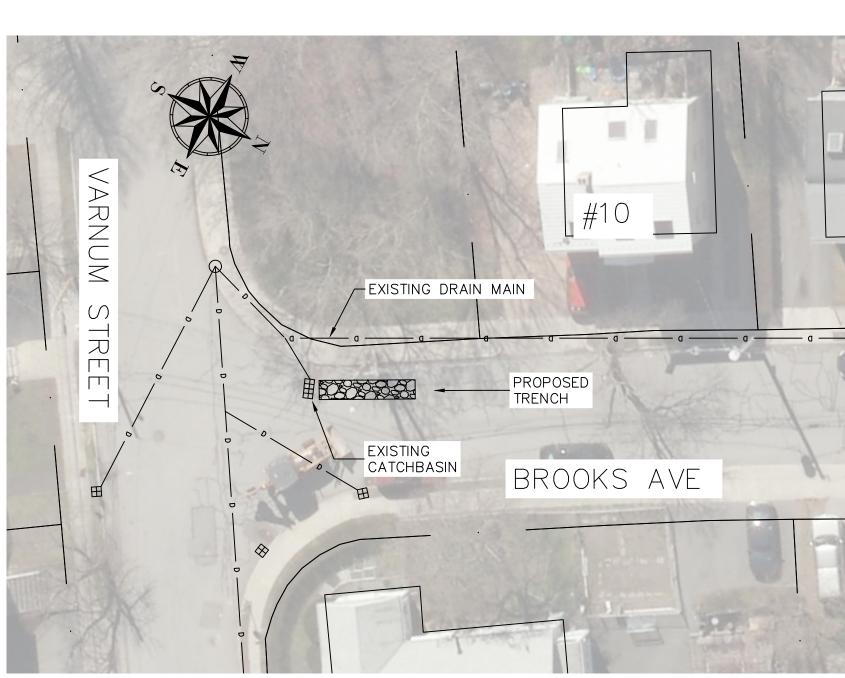


LOCATION #5 - 10 BROOKS AVE

DESIGN &	AS-BUILT TAE	BLE
NEAREST ADDRESS	NEAREST ADDRESS 10 BROOKS AVE	
TRENCH DESIGN	DESIGN	AS-BUILT
LENGTH (FT)	35	
WIDTH (FT)	3.50	
DEPTH (FT)	6.45	
DEPTH EXISTING INV. OUT (FT)	2.70	
DEPTH TRENCH PIPE INV. (FT)	2.95	
IMPERVIOUS AREA (ACRES)	0.45	

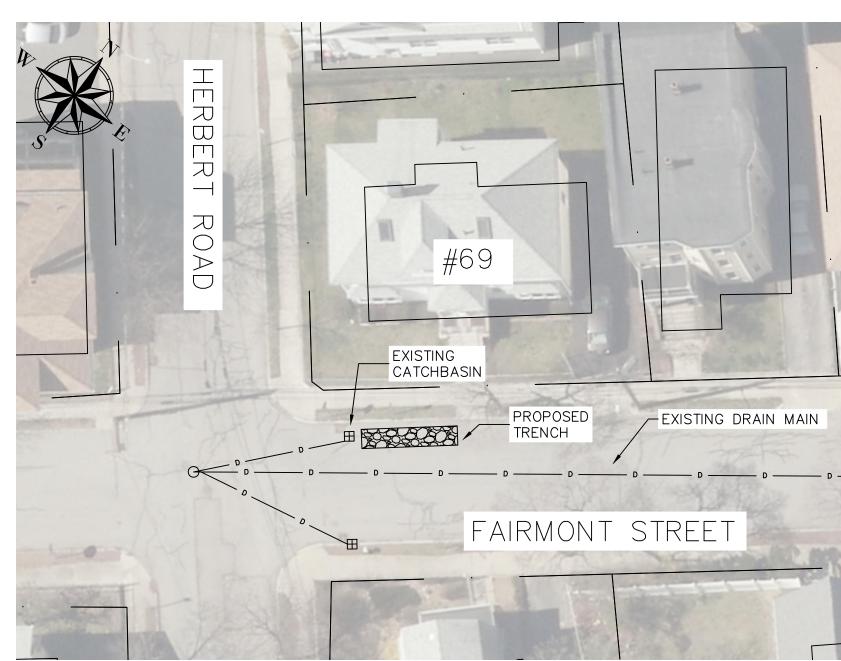

LOCATION #3 - 69 FAIRMONT STREET SCALE: N.T.S.

DESIGN & AS-BUILT TABLE		
NEAREST ADDRESS 69 FAIRMONT STREET		NT STREET
TRENCH DESIGN	DESIGN	AS-BUILT
LENGTH (FT)	30	
WIDTH (FT)	4	
DEPTH (FT)	7	
DEPTH EXISTING INV. OUT (FT)	3.00	
DEPTH TRENCH PIPE INV. (FT)	3.25	
IMPERVIOUS AREA (ACRES)	0.15	

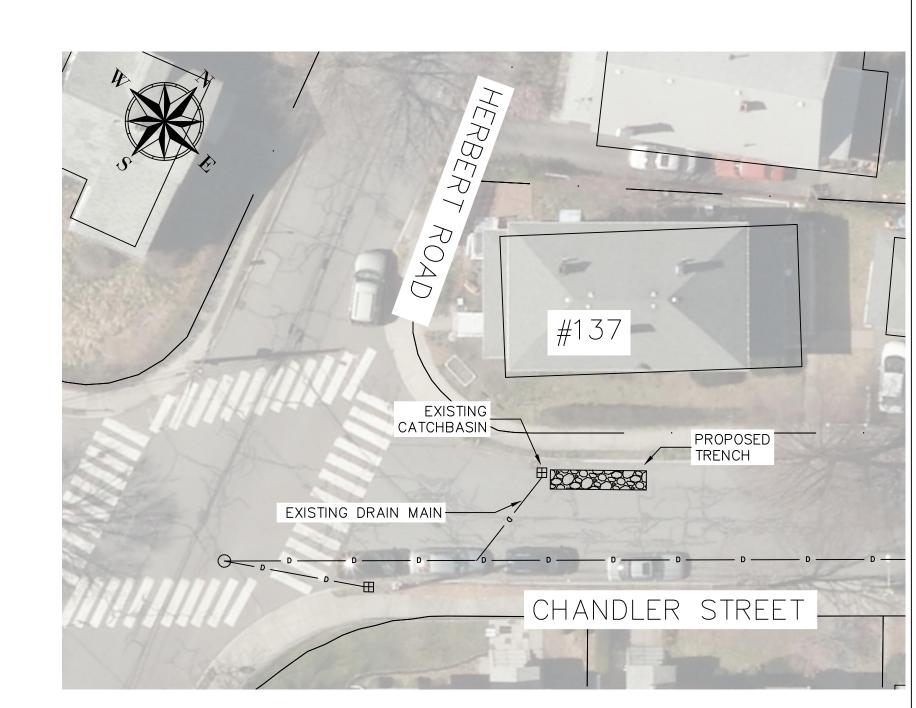

LOCATION #6 - 137 HERBERT ROAD SCALE: N.T.S.

DESIGN & A	S-BUILT TAE	BLE
NEAREST ADDRESS 137 HERBERT ROAL		ERT ROAD
TRENCH DESIGN	DESIGN	AS-BUILT
LENGTH (FT)	35	
WIDTH (FT)	4	
DEPTH (FT)	7.05	
DEPTH EXISTING INV. OUT (FT)	3.30	
DEPTH TRENCH PIPE INV. (FT)	3.55	
IMPERVIOUS AREA (ACRES)	0.29	

NOTES

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 72 HOURS PRIOR TO EXCAVATION BY
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- 1			
	No.	Revision/Issue	Date


Town of ARLINGTON

-Engineering Division
51 Grove Street
Arlington, MA 02476

2022 GREEN INFRASTRUCTURE PROJECT

LOCATIONS 1-6


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Date: FEBRUARY 2022	

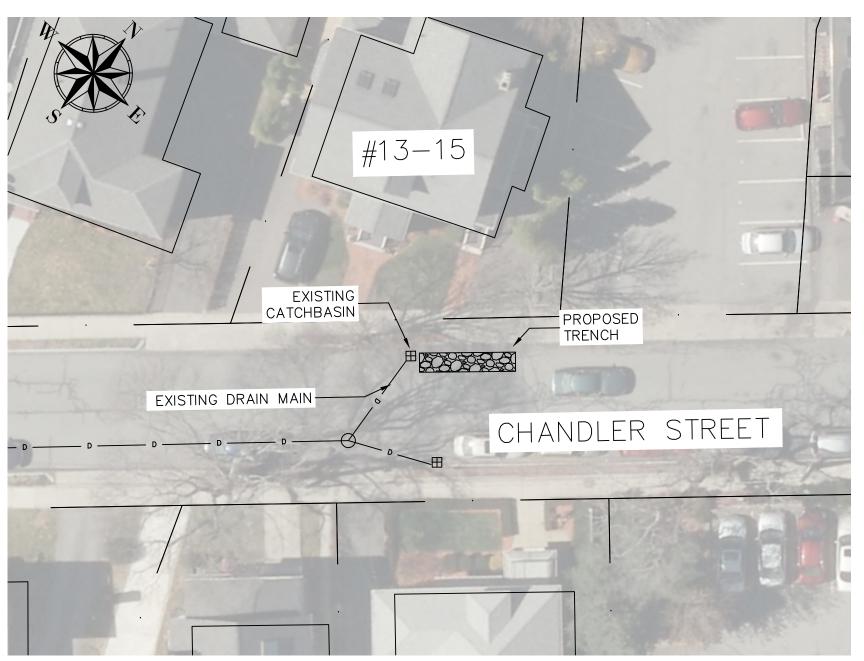

LOCATION#7 - 15 CHANDLER STREET

SCALE: N.T.S.


DESIGN & AS-BUILT TABLE		
NEAREST ADDRESS 15 CHANDLER STREET		
TRENCH DESIGN	DESIGN	AS-BUILT
LENGTH (FT)	35	
WIDTH (FT)	4.50	
DEPTH (FT)	7.15	
DEPTH EXISTING INV. OUT (FT)	3.40	
DEPTH TRENCH PIPE INV. (FT)	3.65	
IMPERVIOUS AREA (ACRES)	0.24	

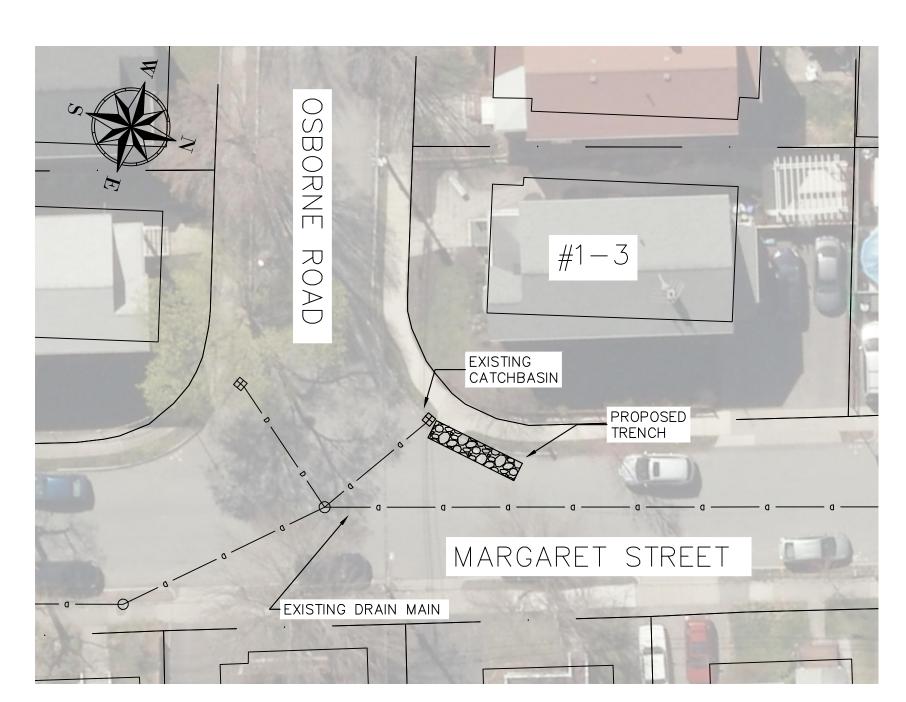

LOCATION #10 - 1 OSBOURNE ROAD

SCALE: N.T.S.


DESIGN & AS-BUILT TABLE		
NEAREST ADDRESS 1 OSBOURNE ROAD		
TRENCH DESIGN	DESIGN	AS-BUILT
LENGTH (FT)	30	
WIDTH (FT)	4.00	
DEPTH (FT)	6.25	
DEPTH EXISTING INV. OUT (FT)	2.50	
DEPTH TRENCH PIPE INV. (FT)	2.75	
IMPERVIOUS AREA (ACRES)	0.15	

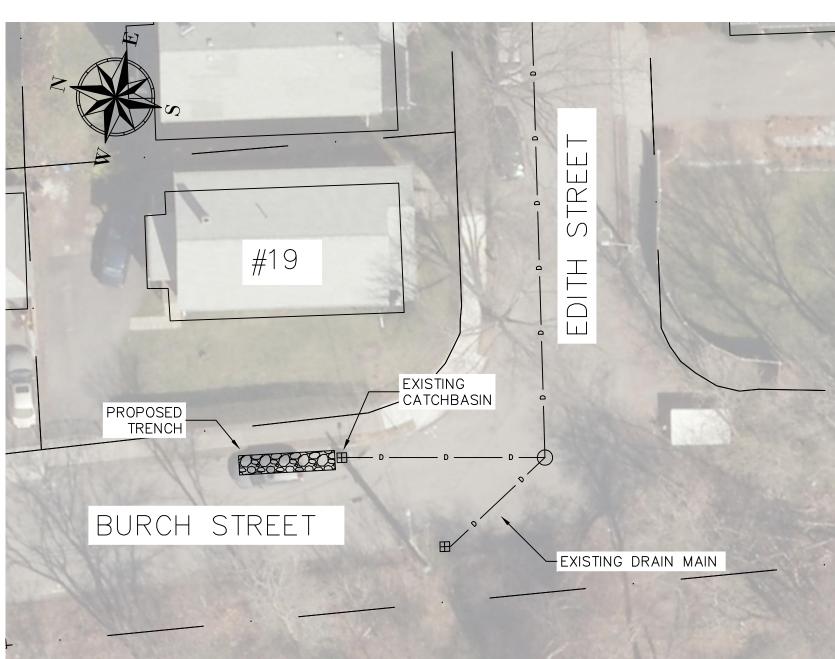

LOCATION #8 - 19 EDITH STREET

SCALE: N.T.S.


DESIGN & AS-BUILT TABLE		
NEAREST ADDRESS 19 EDITH STREET		
TRENCH DESIGN	DESIGN	AS-BUILT
LENGTH (FT)	35	
WIDTH (FT)	3.00	
DEPTH (FT)	6.05	
DEPTH EXISTING INV. OUT (FT)	2.30	
DEPTH TRENCH PIPE INV. (FT)	2.55	
IMPERVIOUS AREA (ACRES)	0.26	

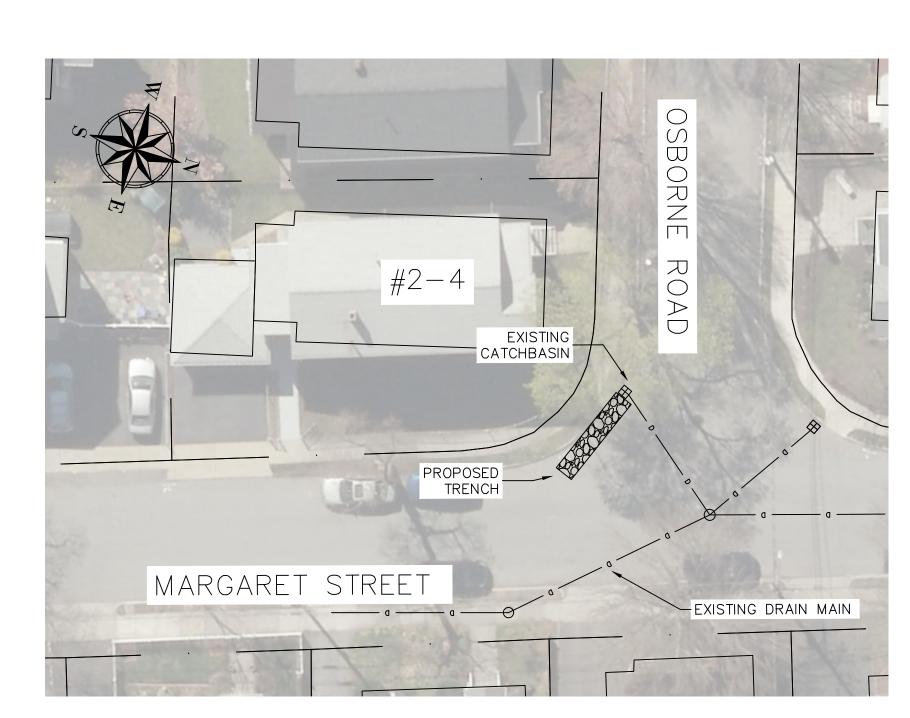

LOCATION #11 - 2 OSBOURNE ROAD


SCALE: N.T.S.

	DESIGN & AS—BUILT TABLE NEAREST ADDRESS 2 OSBOURNE		BLE
			RNE ROAD
	TRENCH DESIGN	DESIGN	AS-BUILT
	LENGTH (FT)	30	
	WIDTH (FT)	4.00	
	DEPTH (FT)	6.15	
	DEPTH EXISTING INV. OUT (FT)	2.40	
	DEPTH TRENCH PIPE INV. (FT)	2.65	
	IMPERVIOUS AREA (ACRES)	0.14	

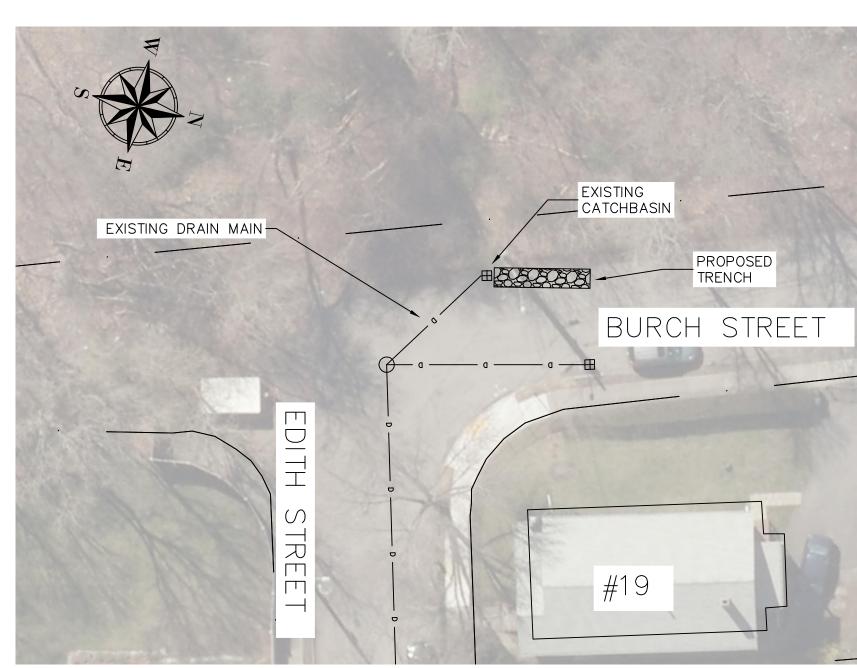

LOCATION #9 - OPP 19 EDITH STREET SCALE: N.T.S.

DESIGN & AS-BUILT TABLE			
NEAREST ADDRESS	OPP 19 EDITH STREET		
TRENCH DESIGN	DESIGN AS-BUILT		
LENGTH (FT)	35		
WIDTH (FT)	4.00		
DEPTH (FT) 6.05			
DEPTH EXISTING INV. OUT (FT)	3.30		
DEPTH TRENCH PIPE INV. (FT)	3.55		
IMPERVIOUS AREA (ACRES)	0.25		

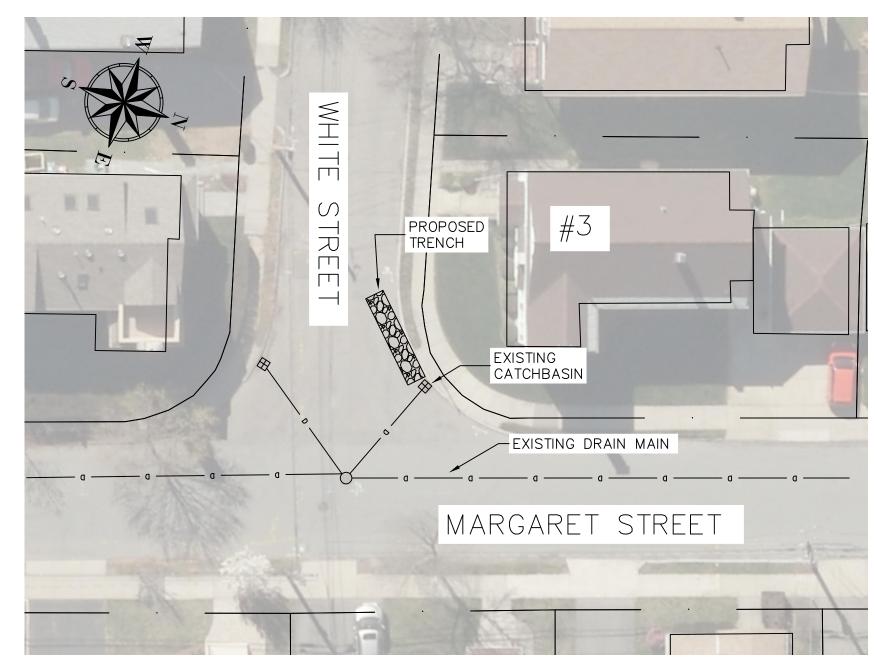

LOCATION #12 - 3 WHITE STREET SCALE: N.T.S.

DESIGN & A	S-BUILT TAE	BLE
NEAREST ADDRESS	3 WHITE	STREET
TRENCH DESIGN	DESIGN	AS-BUILT
LENGTH (FT)	30	
WIDTH (FT)	4.00	
DEPTH (FT)	6.45	
DEPTH EXISTING INV. OUT (FT)	3.20	
DEPTH TRENCH PIPE INV. (FT)	3.45	
IMPERVIOUS AREA (ACRES)	0.23	

NOTES

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No.	Revision/Issue	Date


Town of ARLINGTON Engineering Division

Engineering Division
51 Grove Street
Arlington, MA 02476

2022 GREEN INFRASTRUCTURE PROJECT


LOCATIONS 7-12

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Date: FEBRUARY 2022	

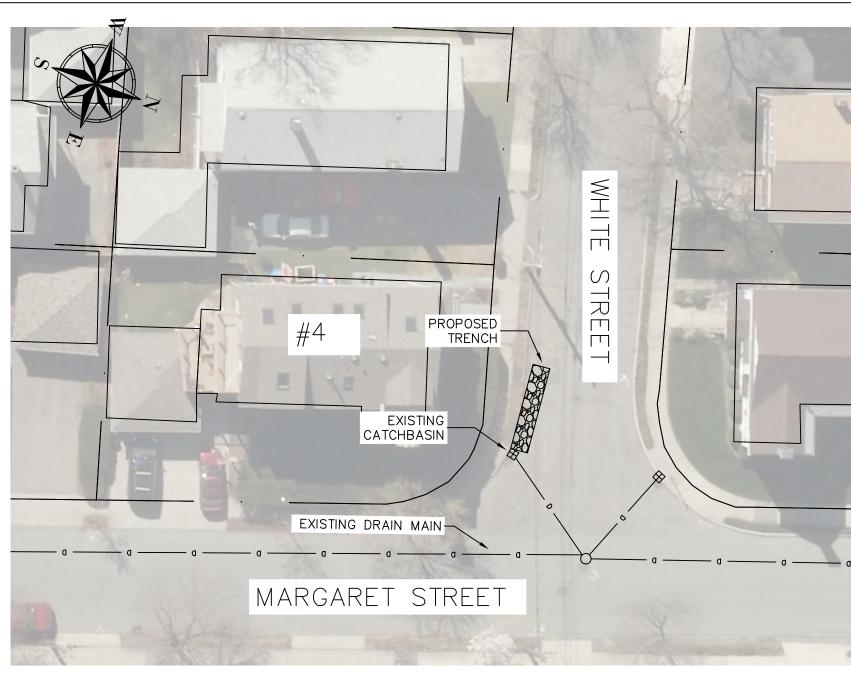


LOCATION#13 - 4 WHITE STREET SCALE: N.T.S.

DESIGN & A	AS-BUILT TAE	BLE
NEAREST ADDRESS 4 WHITE		STREET
TRENCH DESIGN	DESIGN	AS-BUILT
LENGTH (FT)	30	
WIDTH (FT)	4	
DEPTH (FT)	6.35	
DEPTH EXISTING INV. OUT (FT)	3.10	
DEPTH TRENCH PIPE INV. (FT)	3.35	
IMPERVIOUS AREA (ACRES)	0.22	

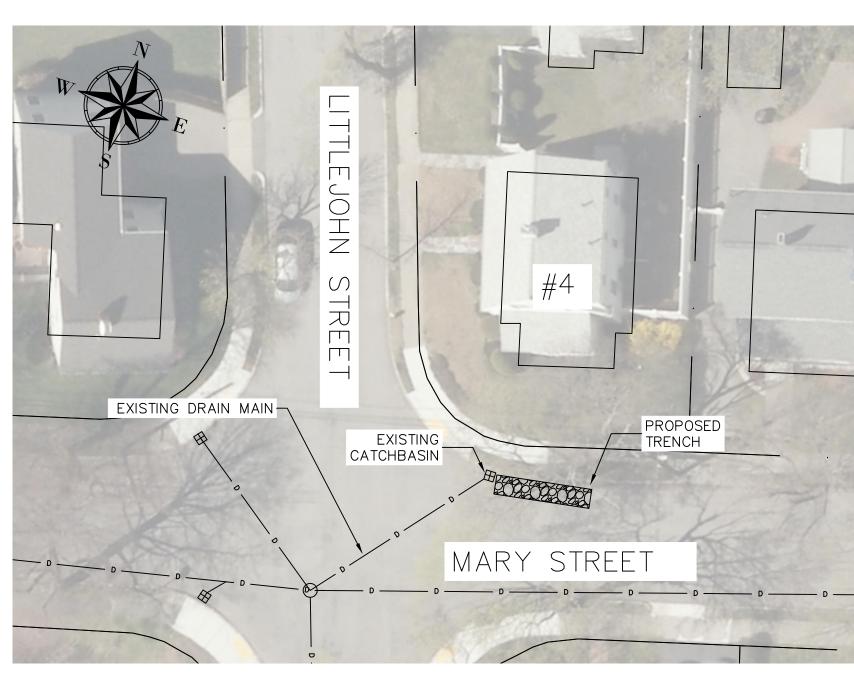


LOCATION #16 - 4 LITTLEJOHN STREET SCALE: N.T.S.

DESIGN & AS-BUILT TABLE			
NEAREST ADDRESS 4 LITTLEJOHN STREET		HN STREET	
TRENCH DESIGN	DESIGN	AS-BUILT	
LENGTH (FT)	30		
WIDTH (FT)	4		
DEPTH (FT)	6.55		
DEPTH EXISTING INV. OUT (FT)	3.30		
DEPTH TRENCH PIPE INV. (FT)	3.55		
IMPERVIOUS AREA (ACRES)	0.19		

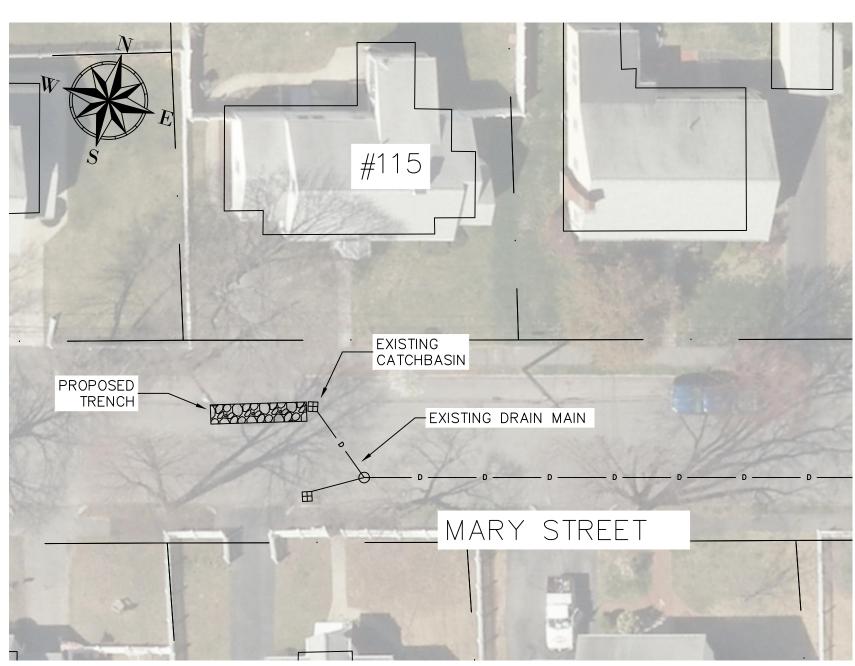


LOCATION #14 - 115 MARY STREET SCALE: N.T.S.

DESIGN & A	AS-BUILT TAE	BLE
NEAREST ADDRESS 115 MARY		Y STREET
TRENCH DESIGN	DESIGN	AS-BUILT
LENGTH (FT)	30	
WIDTH (FT)	4	
DEPTH (FT)	5.95	
DEPTH EXISTING INV. OUT (FT)	1.70	
DEPTH TRENCH PIPE INV. (FT)	1.95	
IMPERVIOUS AREA (ACRES)	0.31	

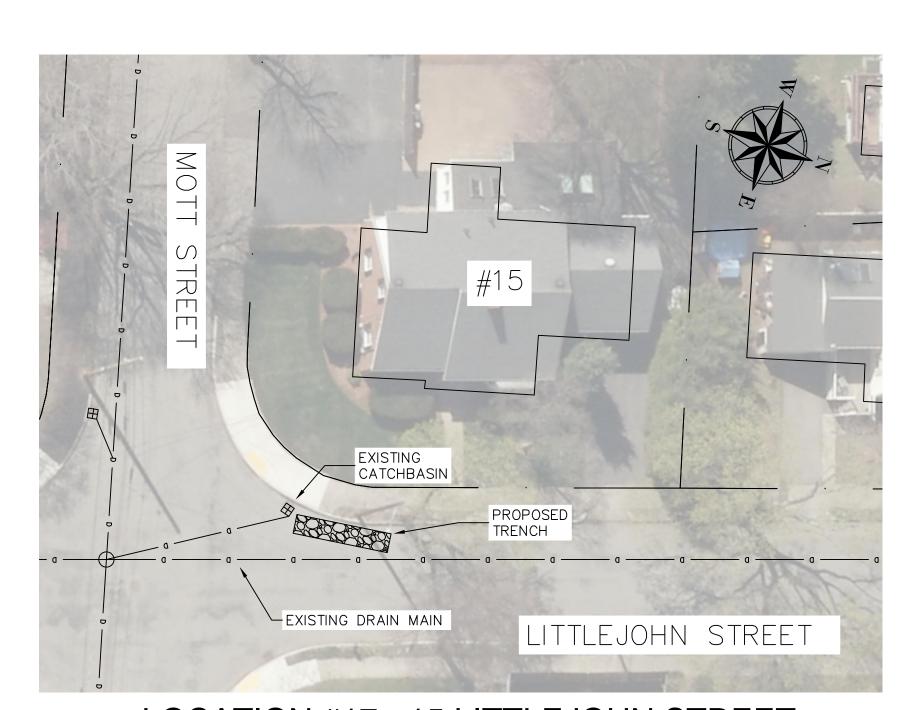


LOCATION #17 - 15 LITTLEJOHN STREET SCALE: N.T.S.

DESIGN & AS-BUILT TABLE			
NEAREST ADDRESS 15 LITTLEJOHN STREET		HN STREET	
TRENCH DESIGN DESIGN AS-BUIL		AS-BUILT	
LENGTH (FT)	30		
WIDTH (FT)	4		
DEPTH (FT)	6.45		
DEPTH EXISTING INV. OUT (FT)	3.20		
DEPTH TRENCH PIPE INV. (FT)	3.45		
IMPERVIOUS AREA (ACRES)	0.16		

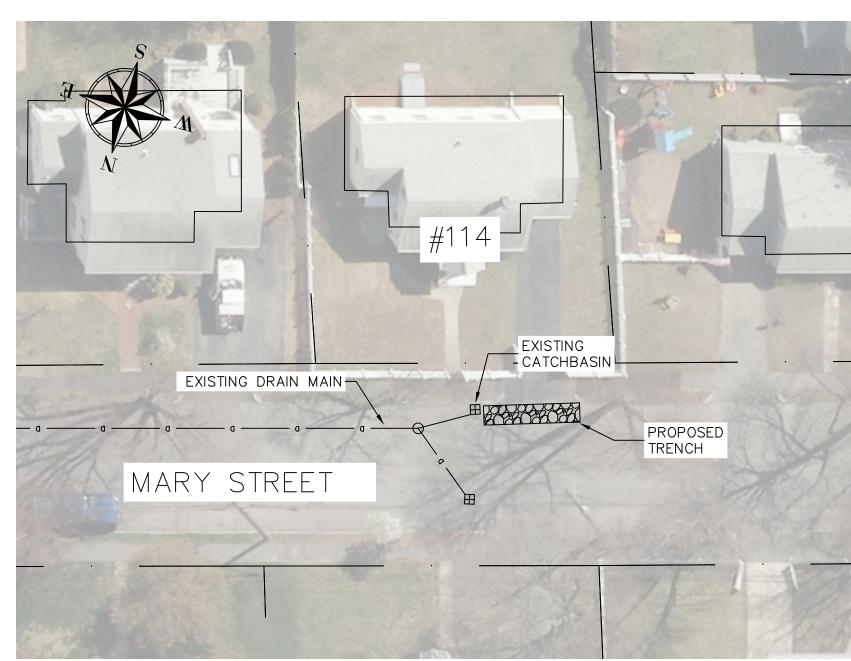

LOCATION #15 - 114 MARY STREET

DESIGN & AS-BUILT TABLE		
NEAREST ADDRESS 114 MARY STREET		Y STREET
TRENCH DESIGN	DESIGN	AS-BUILT
LENGTH (FT)	30	
WIDTH (FT)	4	
DEPTH (FT)	5.95	
DEPTH EXISTING INV. OUT (FT)	2.70	
DEPTH TRENCH PIPE INV. (FT)	2.95	
IMPERVIOUS AREA (ACRES)	0.31	

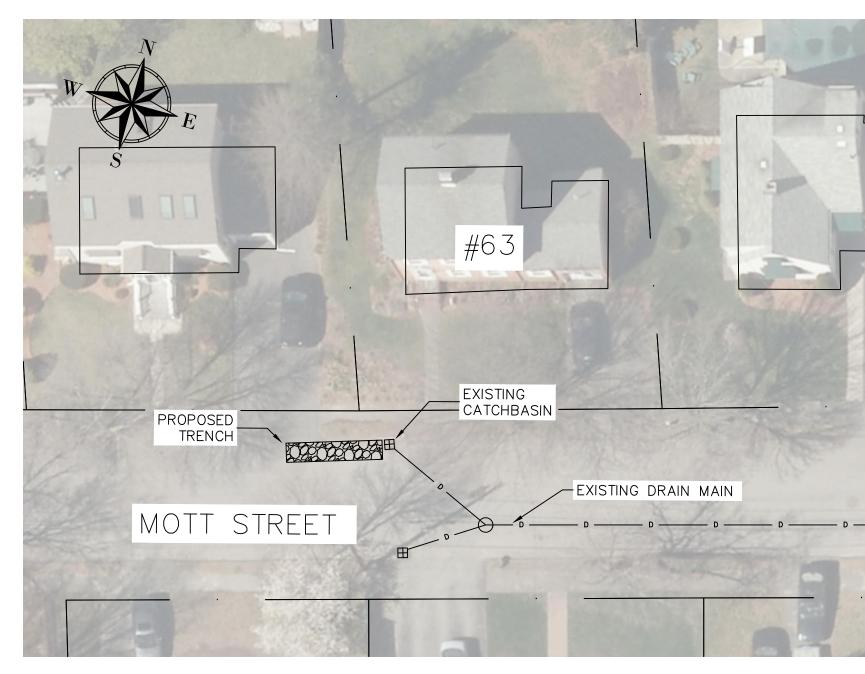

LOCATION #18 - 63 MOTT STREET SCALE: N.T.S.

DESIGN & A	AS-BUILT TAE	BLE
NEAREST ADDRESS	63 MOTT	STREET
TRENCH DESIGN	DESIGN	AS-BUILT
LENGTH (FT)	30	
WIDTH (FT)	4	
DEPTH (FT)	6.00	
DEPTH EXISTING INV. OUT (FT)	2.50	
DEPTH TRENCH PIPE INV. (FT)	2.75	
IMPERVIOUS AREA (ACRES)	0.27	

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No.	Revision/Issue	Date


Town of ARLINGTON Engineering Division

-Engineering Division 51 Grove Street Arlington, MA 02476

2022 GREEN INFRASTRUCTURE PROJECT

LOCATIONS 13-18


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Date: FEBRUARY 2022	

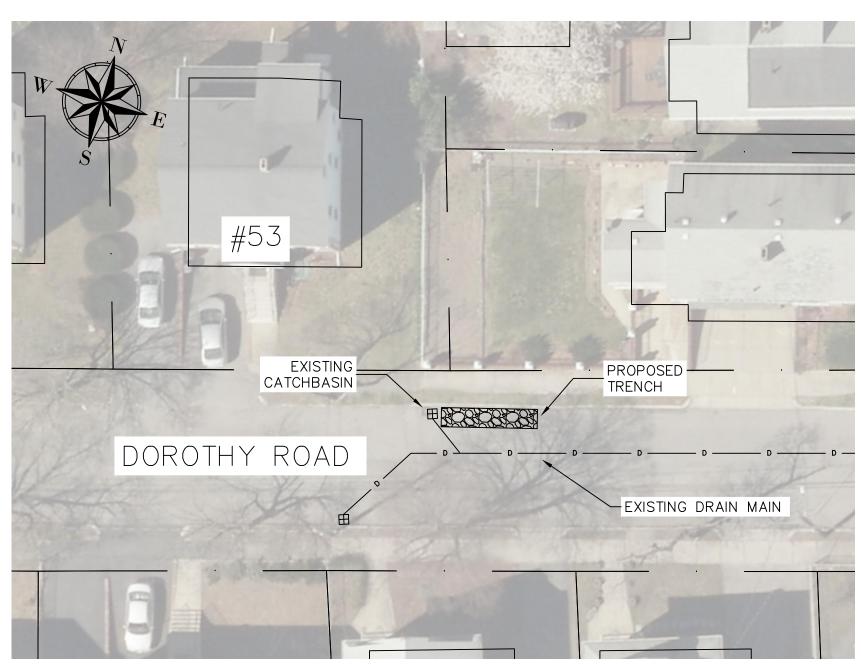

LOCATION#19 - 53 DOROTHY ROAD

SCALE: N.T.S.


DESIGN & AS-BUILT TABLE		
NEAREST ADDRESS	53 DORO	THY ROAD
TRENCH DESIGN	DESIGN	AS-BUILT
LENGTH (FT)	30	
WIDTH (FT)	4	
DEPTH (FT)	5.80	
DEPTH EXISTING INV. OUT (FT)	2.30	
DEPTH TRENCH PIPE INV. (FT)	2.55	
IMPERVIOUS AREA (ACRES)	0.24	

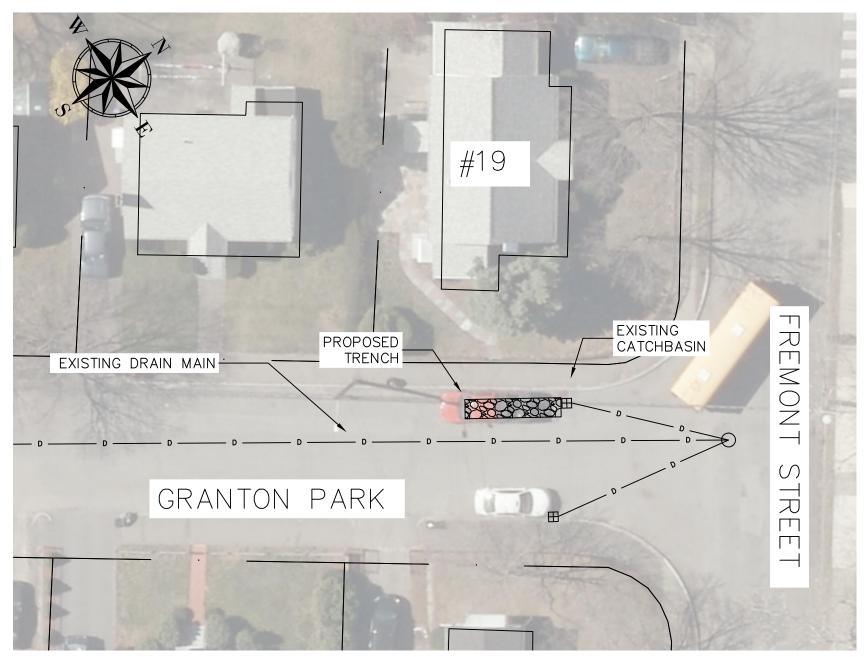

LOCATION #20 - 19 FREMONT STREET

SCALE: N.T.S.


DESIGN & AS-BUILT TABLE			
NEAREST ADDRESS 19 FREMONT STREET		NT STREET	
TRENCH DESIGN	DESIGN	AS-BUILT	
LENGTH (FT)	35		
WIDTH (FT)	4		
DEPTH (FT)	6.35		
DEPTH EXISTING INV. OUT (FT)	3.10		
DEPTH TRENCH PIPE INV. (FT)	3.35		
IMPERVIOUS AREA (ACRES)	0.33		

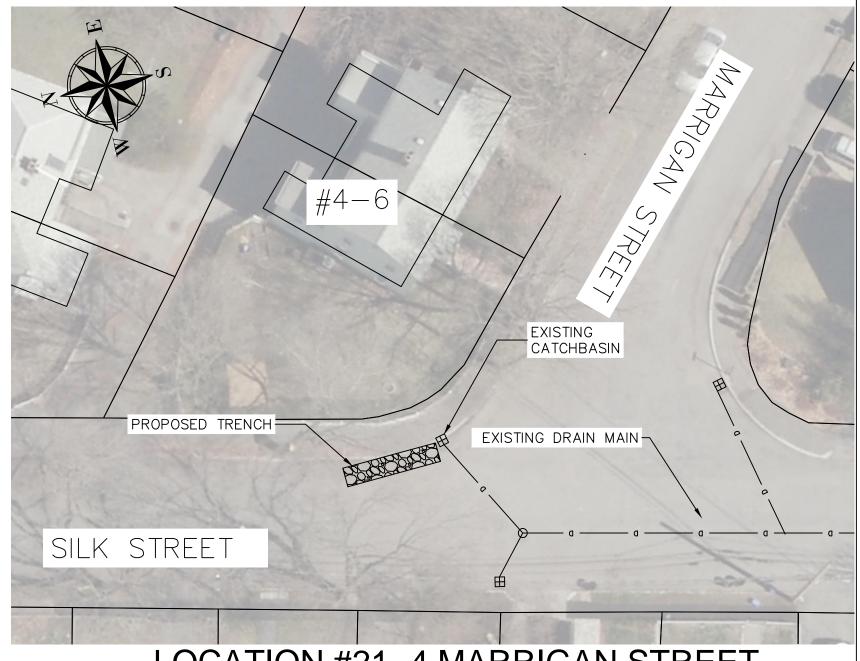

LOCATION #21- 4 MARRIGAN STREET


SCALE: N.T.S.

DESIGN & AS-BUILT TABLE			
NEAREST ADDRESS 4 MARRIGAN STREET		AN STREET	
TRENCH DESIGN	DESIGN	AS-BUILT	
LENGTH (FT)	35		
WIDTH (FT)	4		
DEPTH (FT)	5.85		
DEPTH EXISTING INV. OUT (FT)	3.10		
DEPTH TRENCH PIPE INV. (FT)	3.35		
IMPERVIOUS AREA (ACRES)	0.24		

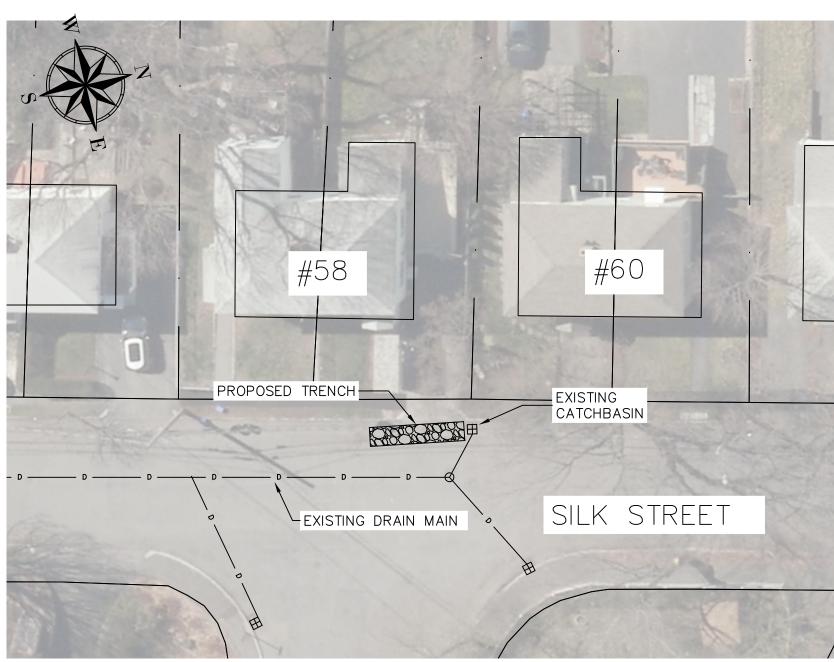

LOCATION #22 - 60 SILK STREET


DESIGN & AS-BUILT TABLE		
NEAREST ADDRESS 60 SILK STREET		STREET
TRENCH DESIGN	DESIGN	AS-BUILT
LENGTH (FT)	30	
WIDTH (FT)	4	
DEPTH (FT)	6.45	
DEPTH EXISTING INV. OUT (FT)	3.20	
DEPTH TRENCH PIPE INV. (FT)	3.45	
IMPERVIOUS AREA (ACRES)	0.28	

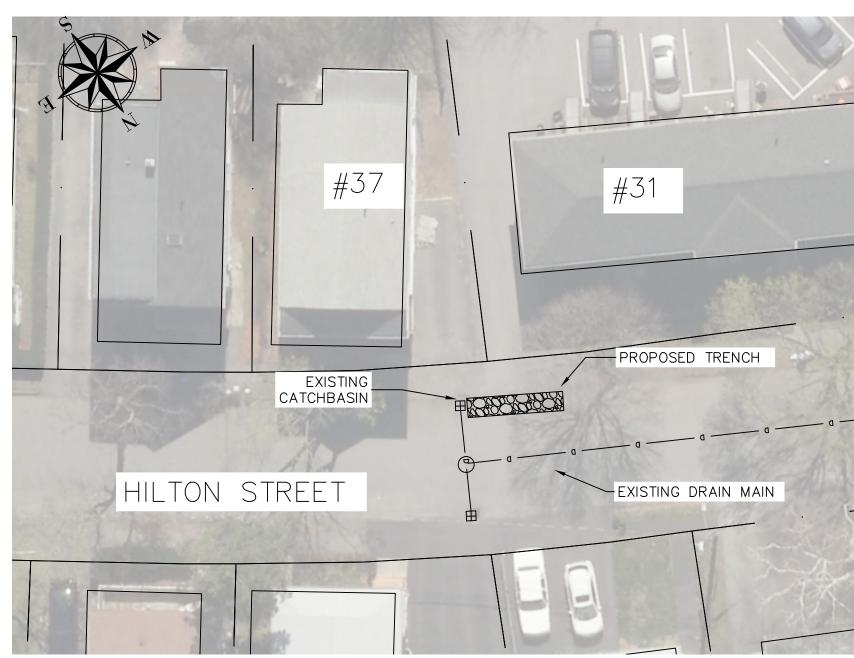

LOCATION #23 - 37 HILTON STREET

SCALE: N.T.S.

DESIGN & AS-BUILT TABLE			
NEAREST ADDRESS 37 HILTON ST		N STREET	
TRENCH DESIGN	DESIGN	AS-BUILT	
LENGTH (FT)	35		
WIDTH (FT)	4		
DEPTH (FT)	6.75		
DEPTH EXISTING INV. OUT (FT)	3.50		
DEPTH TRENCH PIPE INV. (FT)	3.75		
IMPERVIOUS AREA (ACRES)	0.26		

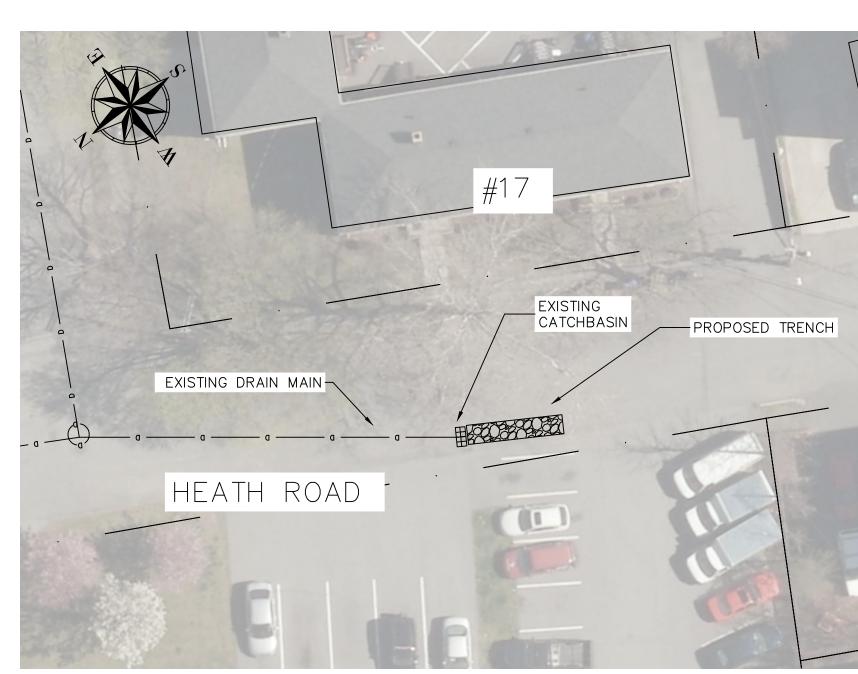

LOCATION #24 - 17 HEATH ROAD

SCALE: N.T.S.

	DESIGN & A	S-BUILT TAE	BLE
Ī	NEAREST ADDRESS	17 HEAT	H ROAD
	TRENCH DESIGN	DESIGN	AS-BUILT
	LENGTH (FT)	35	
	WIDTH (FT)	4	
	DEPTH (FT)	6.35	
	DEPTH EXISTING INV. OUT (FT)	3.10	
	DEPTH TRENCH PIPE INV. (FT)	3.35	
	IMPERVIOUS AREA (ACRES)	0.25	

NOTES

- 1. PLANS WERE DEVELOPED USING AVAILABLE AERIAL IMAGERY, EXISTING PLANS, AND ON-SITE OBSERVATIONS. A FORMAL SURVEY OF THE PROJECT AREAS WAS NOT CONDUCTED. UTILITY LOCATIONS AND INVERT MEASUREMENTS ARE APPROXIMATE.
- 2. CONTRACTOR IS RESPONSIBLE FOR NOTIFYING DIG-SAFE AND ALL APPLICABLE UTILITIES OF THE PROPOSED WORK PRIOR TO ANY EXCAVATION. THE TOWN OF ARLINGTON IS NOT A MEMBER OF DIG-SAFE AND MUST BE NOTIFIED DIRECTLY AT LEAST 72 HOURS PRIOR TO EXCAVATION BY CALLING 781-316-3310.
- 3. TRENCHES HAVE BEEN PROPOSED IN LOCATIONS WHERE NO UTILITY CONFLICTS WERE APPARENT. THE CONTRACTOR IS RESPONSIBLE FOR CONTACTING ALL APPLICABLE UTILITIES FOR APPROPRIATE MARK-OUTS AND CONFIRMING NO CONFLICTS ARE PRESENT. THE CONTRACTOR IS RESPONSIBLE FOR NOTIFYING THE ENGINEER SHOULD ANY EXISTING UTILITY CONFLICTS BE IDENTIFIED WITHIN PROPOSED TRENCH LIMITS.
- 4. CONTRACTOR IS RESPONSIBLE FOR NOTIFYING RESIDENTS AND ABUTTERS OF ANY WORK THAT MAY INTERFERE WITH DRIVEWAY AND WALKWAY ACCESS.
- 5. A RELATIVE LOCAL DATUM HAS BEEN SET FOR EACH TRENCH LOCATION. THE CATCHBASIN RIM ELEVATION HAS BEEN SET TO ZERO FEET (0.0') AT EACH LOCATION.
- 6. EXISTING ASPHALT SHOULD BE SAWCUT PRIOR TO EXCAVATION.
- 7. TRENCHES SHOULD BE BACKFILLED AND COMPACTED IN 12 INCH LIFTS.
- 8. CONTRACTOR IS RESPONSIBLE FOR APPROPRIATE CONSTRUCTION SIGNAGE AND BARRIERS AS NEEDED AND SHALL BE INCIDENTAL TO THE CONTRACT.
- 9. CONTRACTOR TO MAINTAIN CLEAN WORK ZONE AND SWEEP WORK SITE DAILY.
- 10. PAVING TO BE COMPLETED WEEKLY.
- 11. EROSION CONTROL SHALL BE USED WHEN NECESSARY AND CONSIDERED INCIDENTAL TO THE CONTRACT. ANY SEDIMENT THAT ENTERS THE TOWN'S STORMWATER SYSTEM AS A RESULT OF CONSTRUCTION SHALL BE REMOVED AT THE EXPENSE OF THE CONTRACTOR.
- 12. CONTRACTOR SHOULD TAKE CARE TO NOT IMPACT NEARBY TREES DURING CONSTRUCTION.
- 13. ANY AREA DISTURBED BY THE CONTRACTOR OUTSIDE OF THE LIMITS OF WORK SHALL BE RESTORED TO ORIGINAL CONDITION AT NO COST TO THE OWNER.

No.	Revision/Issue	Date


Town of ARLINGTON Engineering Division


-Engineering Division
51 Grove Street
Arlington, MA 02476


2022 GREEN INFRASTRUCTURE PROJECT


LOCATIONS 19-24

Drawn By:	Sheet:
Verified By: WCC	
Scale: NTS	[C-4
Date: FEBRUARY 2022	

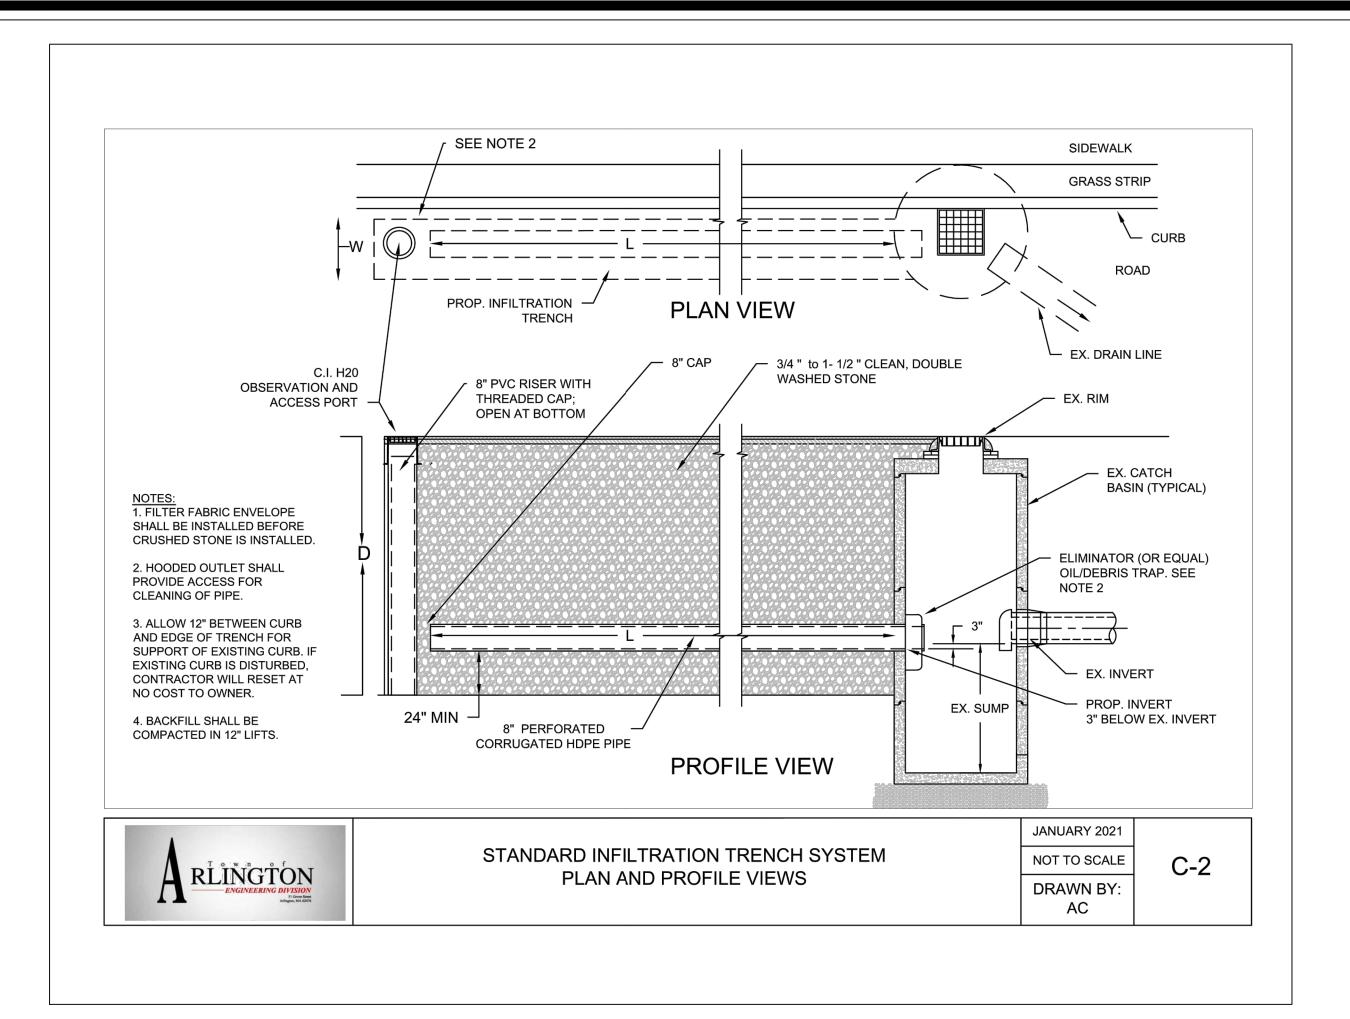

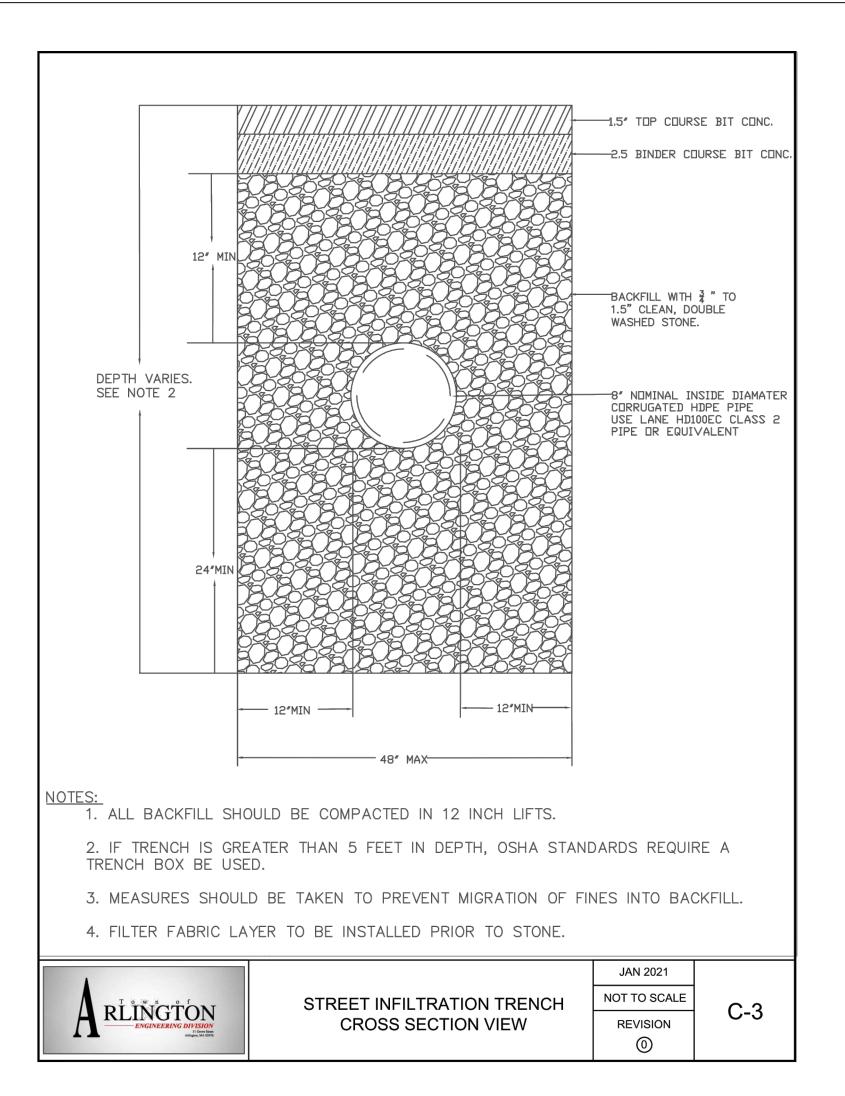

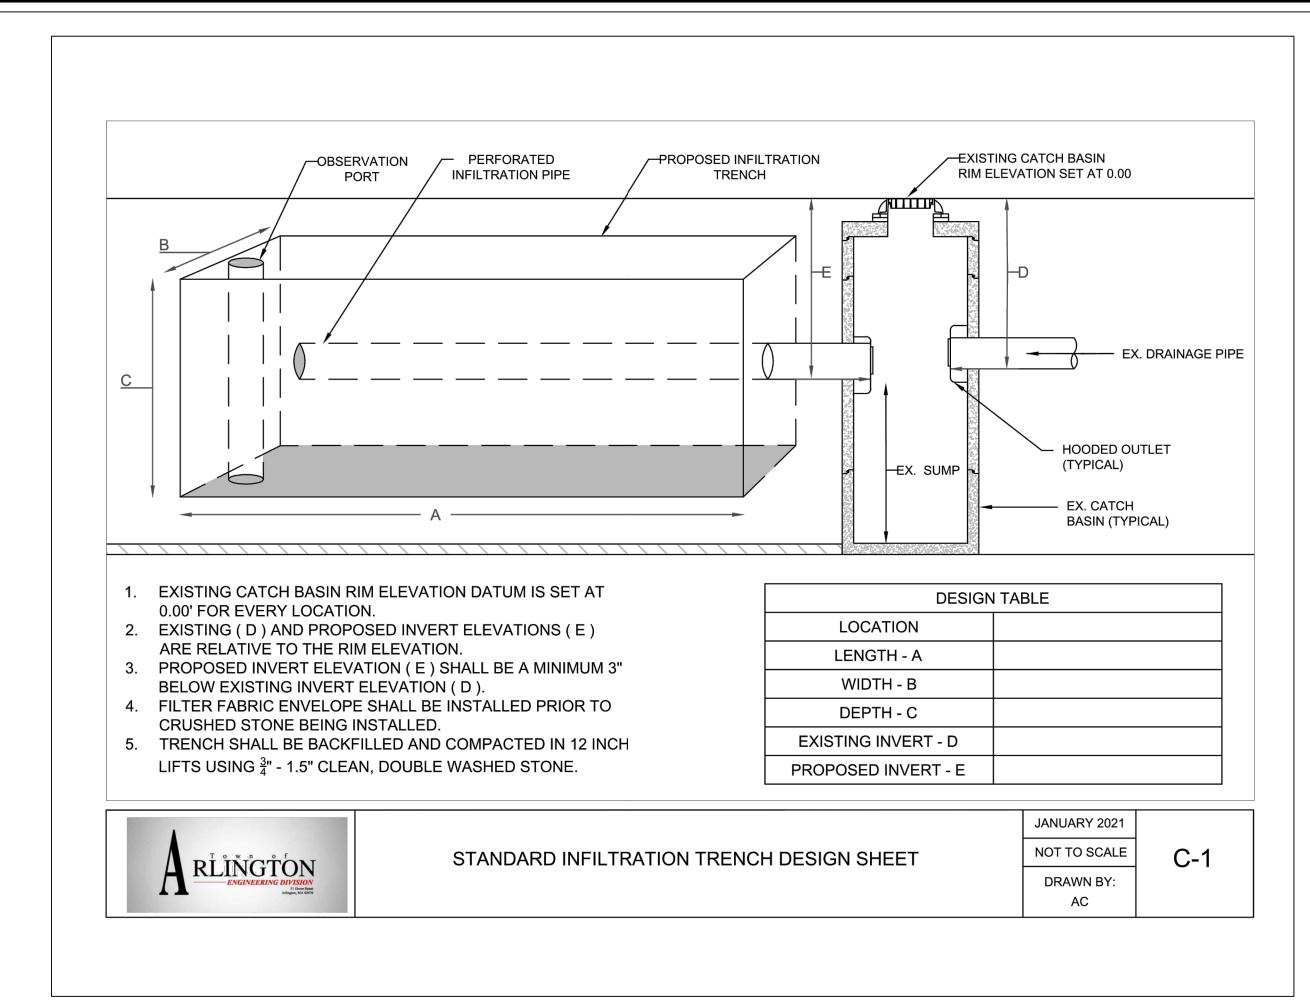

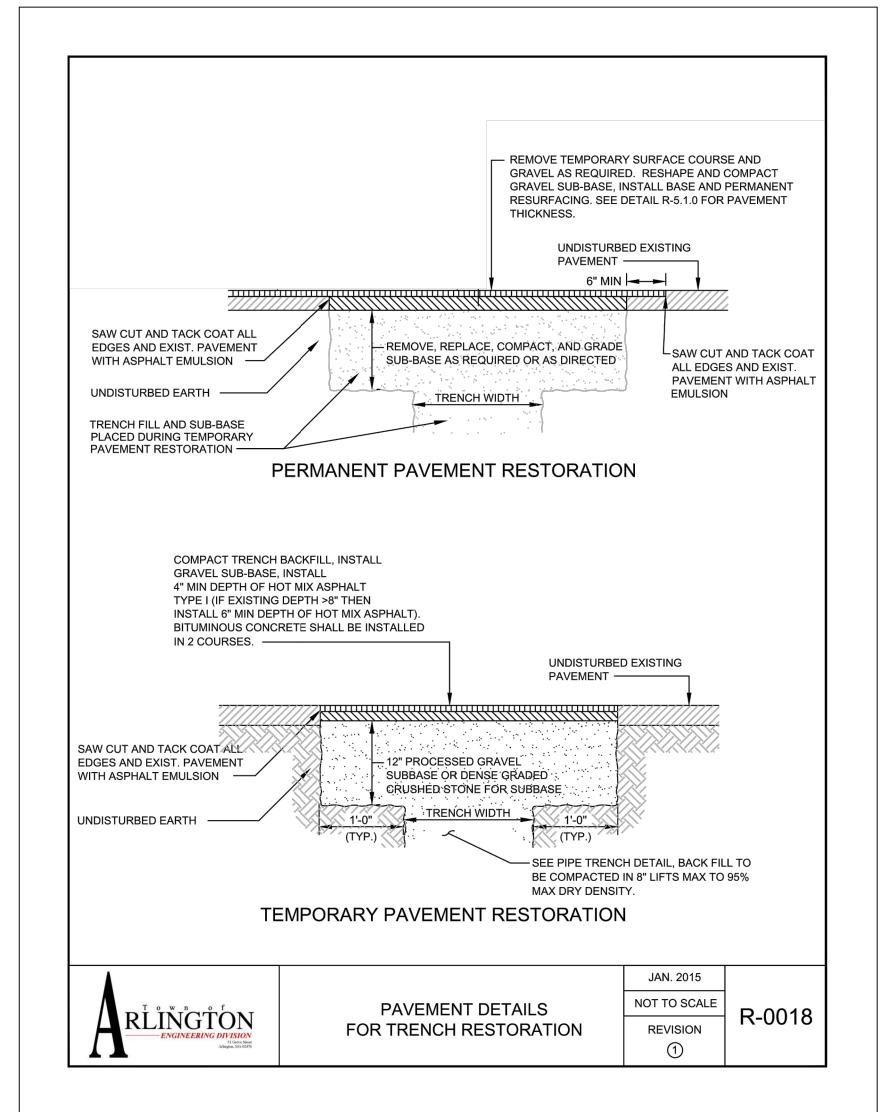

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No. Revision/Issue Date

ARLINGTON

-Engineering Division 51 Grove Street Arlington, MA 02476

2022 GREEN INFRASTRUCTURE PROJECT

STANDARD CONSTRUCTION DETAILS

Drawn By:

AC

Verified By:

WCC

Scale:

NTS

Date:

FEBRUARY 2022